# PROPOSED 2ND DWELLING UNIT IN BASEMENT- 863 WHITLOCK AVE, MILTON ON

PLAN 20M1227 LOT154

# SHEET LIST NUMBER NAME DATE

A00	COVER	15/08/2022
A00	GENERAL NOTES	15/08/2022
A001	SURVEY PLAN	15/08/2022
A100	SITE PLAN	15/08/2022
A101	EXISTING BASEMENT	15/08/2022
A102	PROPOSED BASEMENT	15/08/2022
A103	1ST FLOOR PLAN	15/08/2022
A104	2ND FLOOR PLAN	15/08/2022
A105	SIDE ELEVATION	15/08/2022
A106	REAR ELEVATION	15/08/2022



#### **EXISTING CONC. WALL**

- 2X4 STUD(NEW) W/ EXISTING R-19 INSULATION
- 6MIL POLY VAPOR BARRIER (NEW)
- 12.9mm DRYWALL (NEW)



#### INTERIOR DRYWALL PARTITION (15 MIN.)

- 1/2" GYPSUM BOARD
- 2" X 4" STUDS @400 O.C.
- 1/2" GYPSUM BOARD



INTERIOR FIRE SEPARATION WALL PARTITION (30 MIN.)

- 2" X 4" STUDS @400mm O.C.
- 89mm THICK ABSORPTIVE MATERIAL
- 12.7mm TYPE X GYPSUM BOARD ON BOTH SIDES
- 1 LAYERS ON ONE SIDE



BASEMENT CEILING (30 MIN.) \* STC 50


- WOOD JOIST OR WOOD I-JOISTS SPACED NOT MORE THAN 610mm O.C.
- WITH ABSORPTIVE MATERIAL IN CAVITY
- RESILIENT METAL CHANNELS SPACED 610mm O.C.
- 15.9mm TYPE X GYPSUM BOARD(2 LAYERS)



**DUPLEX RECEPTACLE OUTLET** 



**GROUND FAULT CURRENT** INTERUPTER RECEPTACLE OUTLET

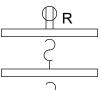

3

RANGE RECEPTACLE OUTLET

LIGHT SWITCH

3 WAY SWITCH AT THE TOP AND BOTTOM OF STAIR

LIGHT FIXTURE



**EXHAUST FAN** 



AIR REGISTER COMPLIANCE WITH OBC DIV B. 9.33.3.1.(1)



RETURN AIR GRILL



**SMOKE ALARM** 



**SPRINKLER** 

CARBON MONOXIDE ALARM



**DUCT TYPE SMOKE DETECTOR** 

6.

8.

2.

3.

4.

5.

AS PER OBC 9.10.13.13. FIRE STOP FLAPS REQUIRED ON ALL OPENINGS IN CEILING. OBC 9.10.13.14. 7.

**GENERAL NOTES -**

ENSURE THE REQUIREMENT OF SHUT-OFF VALVES ON HOT AND COLD WATER SUPPLY TO EACH UNIT FOR SERVICE/REPAIR. AS PER OBC 7.6.1.6.

FIRE DAMPERS REQUIRED FOR DUCTS THAT PENETRATE FIRE SEPARATIONS

ALL WORK SHALL CONFORM TO THE REQUIREMENTS OF THE ONTARIO

REQUIRE AN ADDITIONAL REVISION PERMIT.

AN ELECTRICAL OUTLET.

AUTHORITY.

FOLLOWED BY 4M MINUTES OF ALARM SIGNALING

PROVIDE CARBON MONOXIDE ALARMS CONFORMING TO

BUILDING CODE, O.REG. 332/12; AND ANY CONSTRUCTION CHANGES MADE

HARDWIRED AND INTERCONNECTED IN ACCORDANCE WITH THE REVIEWED

ADJACENT TO EACH SLEEPING AREA. CARBON MONOXIDE ALARMS MAY BE

HARDWIRED BATTERY OPERATED OR THE TYPE THAT CAN BE PLUGGED INTO

PIPING, TUBING, DUCTS, CHIMNEYS, WIRING, CONDUIT, ELECTRICAL OUTLET

THAT ARE NOT A PART OF THE ISSUED REVIEWD PERMIT DRAWINGS WILL

SMOKE ALARMS SHALL BE INSTALLED ON OR NEAR THE CEILING AND IN CONFORMANCE WITH CAN/ULC-S553, "INSTALLATION OF SMOKE ALARMS".

SMOKE SHALL INCLUDE A VISUAL SIGNALING COMPONENT AND BE

DRAWINGS. SMOKE ALARMS SHALL HAVE BATTERY BACKUP POWER

CAPABLE OF LASTING FOR 7 DAYS WHILE IN THE NORMAL CONDITION,

CAN/CSA-6.19, "RESIDENTIAL CARBON MONOXIDE ALARMING DEVICES"

ELECTRICAL WORK MUST BE INSPECTED BY THE ELCTRICAL SAFETY

BOXES AND OTHER SIMILAR SERVICE EQUIPMENT THAT PENETRATE A REQUIRED FIRE SEPARATION SHALL BE TIGHTLY FITTED OR FIRE STOPPED TO MAINTAIN THE INTEGRITY OF THE SEPARATION AS PER OBC 9.10.9.6.

**EMERGENCY LIGHTING** 



MINIMUM 20 MIN. FR W/ SELF-CLOSING DEVICE



EXHAUST DUCTS DIRECTLY CONNECTED TO LAUNDRY DRYING EQUIPMENT SHALL BE INDEPENDENT OF OTHER EXHAUST DUCTS

- \* ABSORPTIVE MATERIAL INCLUDES:
- FIBRE PROCESSED FROM ROCK OR SLAG WITH A MIN. THICKNESS OF 90 MM AND A MIN. SURFACE MASS OF 2.8 kg/sq.m. or
- SPRAY APPLIED CELLULOSE FIBRE WITH AMIN. DENSITY OF 50 kg/cu.m. AND MIN. DEPTH OF 90 MM ON THE UNDERSIDE OF THE SUBFLOOR AND OF 90 mm ON THE IDES OF THE FLOOR JOISTS.


NOTE: MINIMUM STC RATING REQUIRED TO ACHIEVE IS 50 AS PER OBC 9.11


#### CONSTRUCTION REQUIREMENTS FOR FIRE STOP FLAPS:

1. FIRE STOP FLAPS SHALL BE CONSTRUCTED OF STEEL NOT LESS THAN 1.5mm THICK, COVERED ON BOTH SIDED WITH PAINTED ASBESTOS PAPER NOT LESS THAN 1.6mm THICK AND EQUIPPED WITH PINS AND HINGES OF CORROSION-RESISTANT MATERIAL.

#### CONSTRUCTION REQUIREMENTS FOR FIRE DAMPERS:

- 1. DAMPER SHALL BE SECURED TO SLEEVE WITH #10 SHEET METAL SCREWS 6" O.C.. 1.4" NUTS AND BOLTS, WELDING, 3/16" STEEL POP RIVETS OR CLINCHING(TOGGLE).
- 2. ANGLES SHALL BE A MIN. OF 1-1/2" X 1-1/2" X 16 GAUGE OR MAY BE OF A UNIT TYPE CONSTRUCTION.
- 3. FASTEN TO SLEEVE WITH 1/4" DIAMETER NUTS AND BOLTS. WELDING 8" O.C., #8 STEEL MEATL SCREWS 8" O.C. OR 3/16" STEEL POP RIVETS.

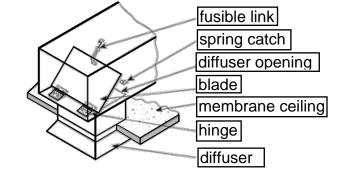

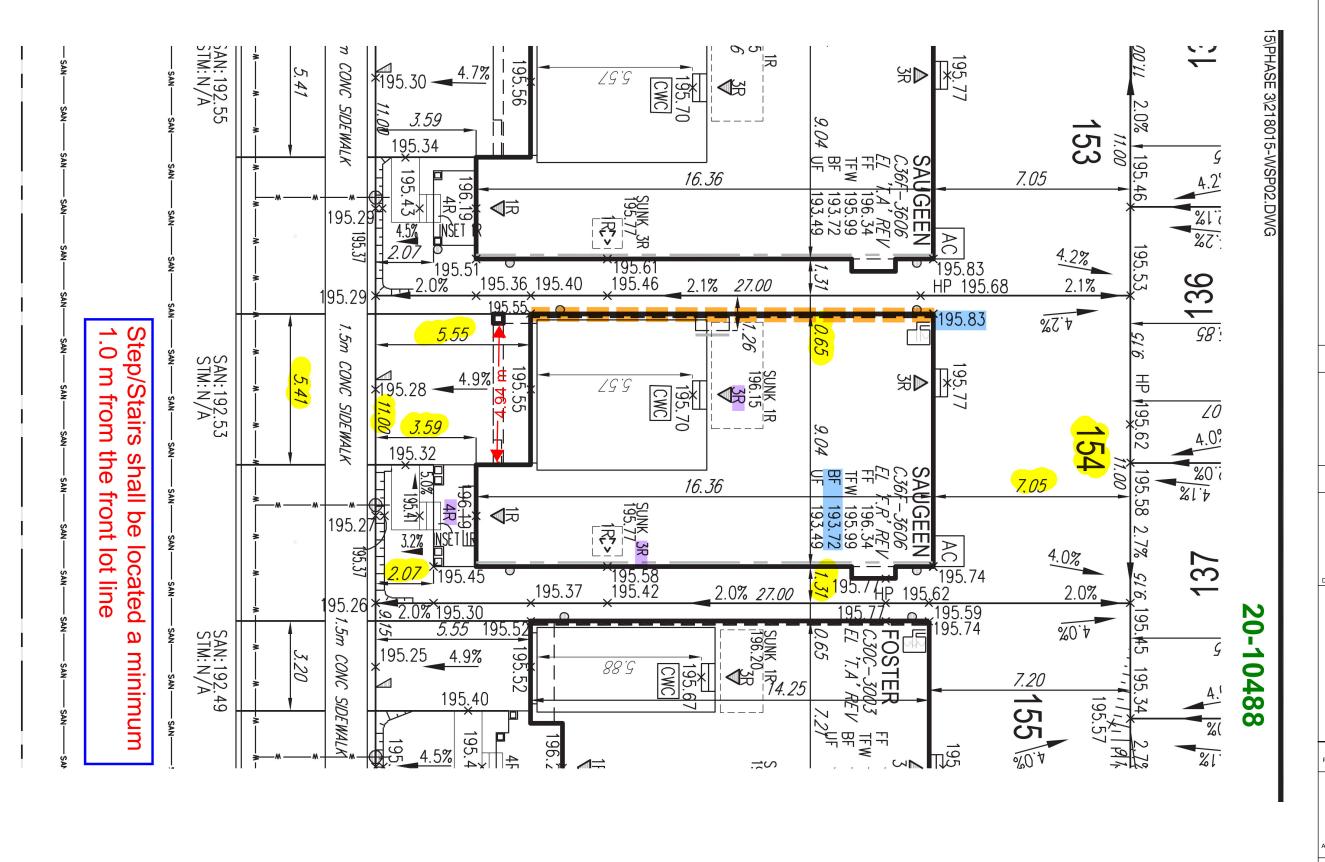

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#### **DESIGNER INFO:**

THE UNDERSIGNED HAS REVIEWED AND TAKES RESPONSIBILITY FOR THIS DESIGN, AND HAS THE QUALIFICATIONS AND MEETS THE REQUIREMENTS SET OUT IN THE ONTARIO BUILDING CODE TO DESIGN THE WORK SHOWN ON THE ATTACHED DOCUMENTS


	ON THE ATTACHED DOCUMENTS		
TARANJOT SINGH	BCIN 114841		
SIGNER SIGN:			

Proposed 2nd Dwelling

863 Whitlock Ave Milton, ON L9E 1R8

ADDRESS:

WG TITLE:	SURVEY PL	AN
CALE:		ΔΛ

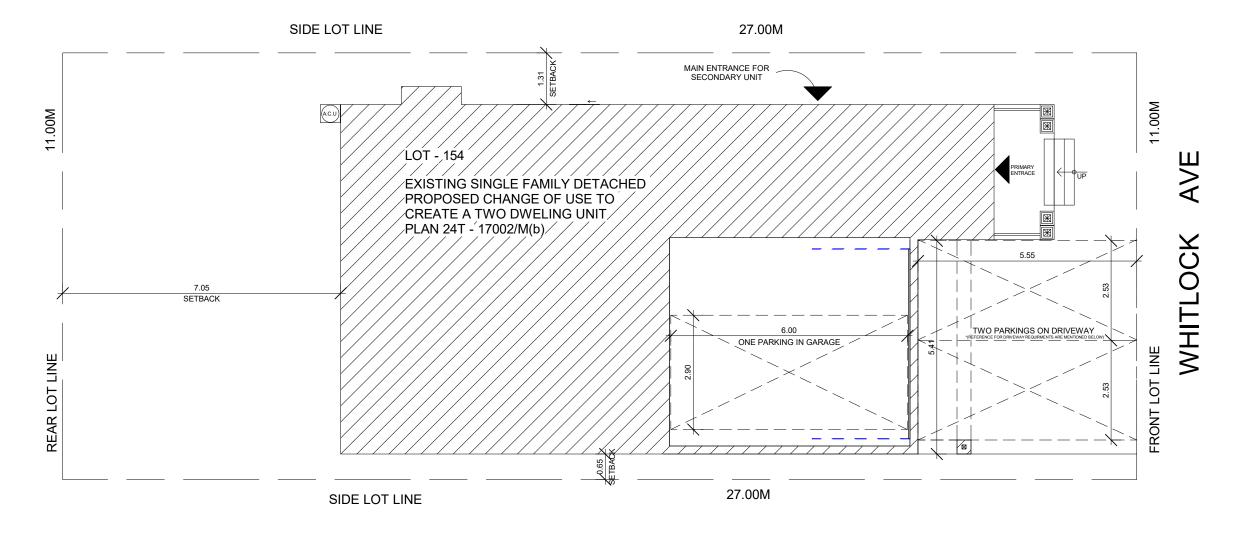





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PROJECT: Proposed 2nd Dwelling

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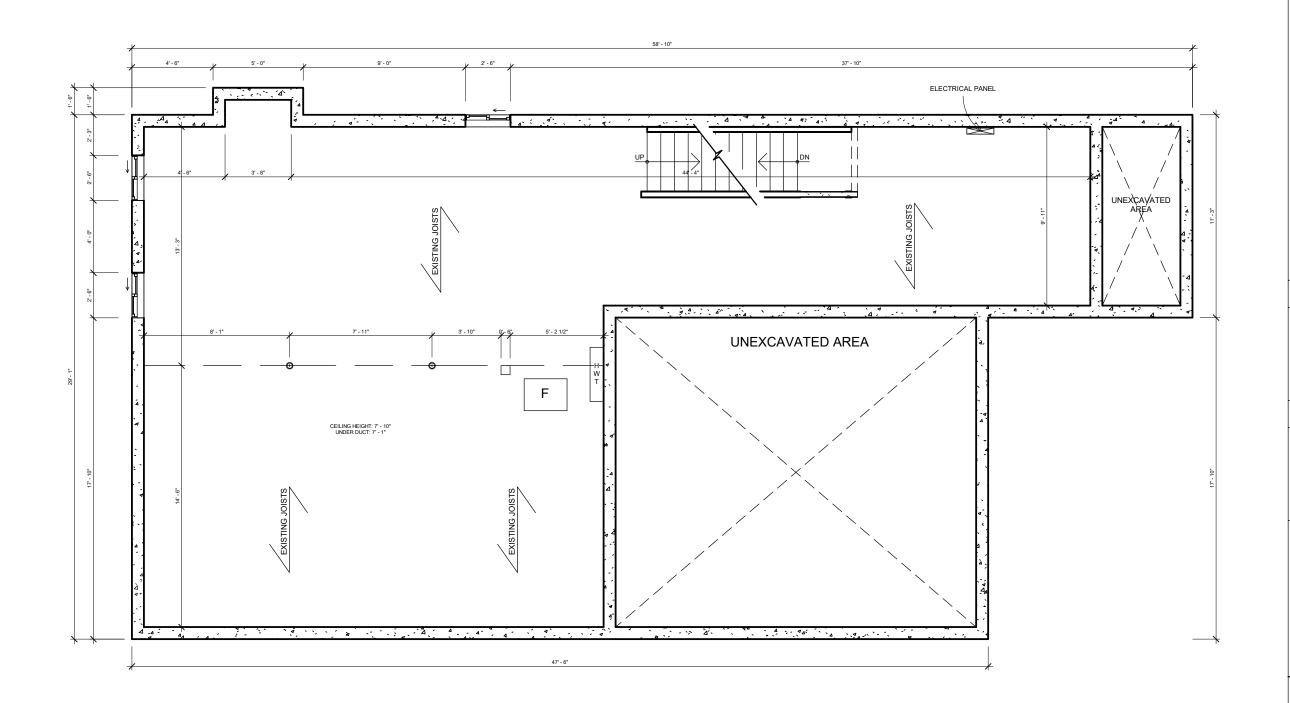
ADDRESS:

DWG TITLE: SITE PLAN

SCALE: 1/8" = 1'-0"

PROJECT NO: 0001

A100



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BCIN 114841

Taranjot Singh


DESIGNER SIGN:

Proposed 2nd Dwelling

863 Whitlock Ave Milton, ON L9E 1R8

DWG TITLE: EXISTING BASEMENT PLAN

 $_{\text{SCALE}:}$  3/16" = 1'-0"

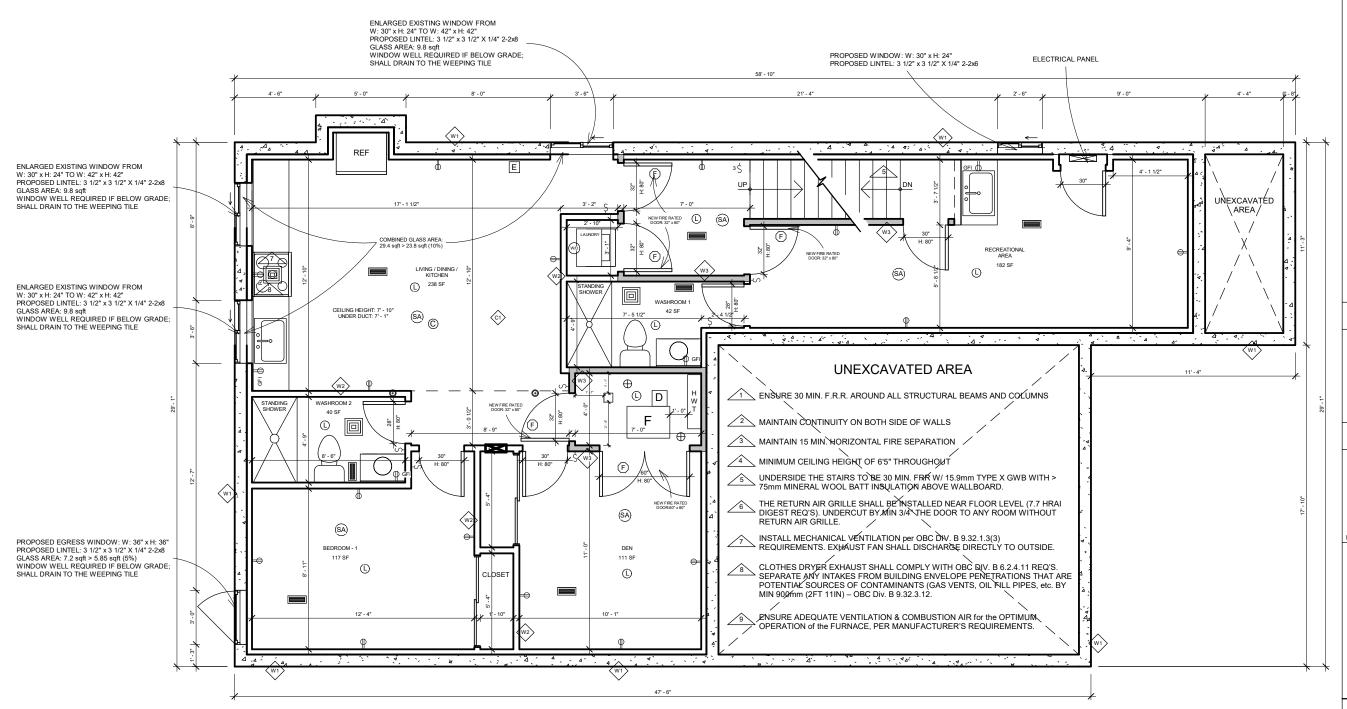



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BCIN 114841

Taranjot Singh

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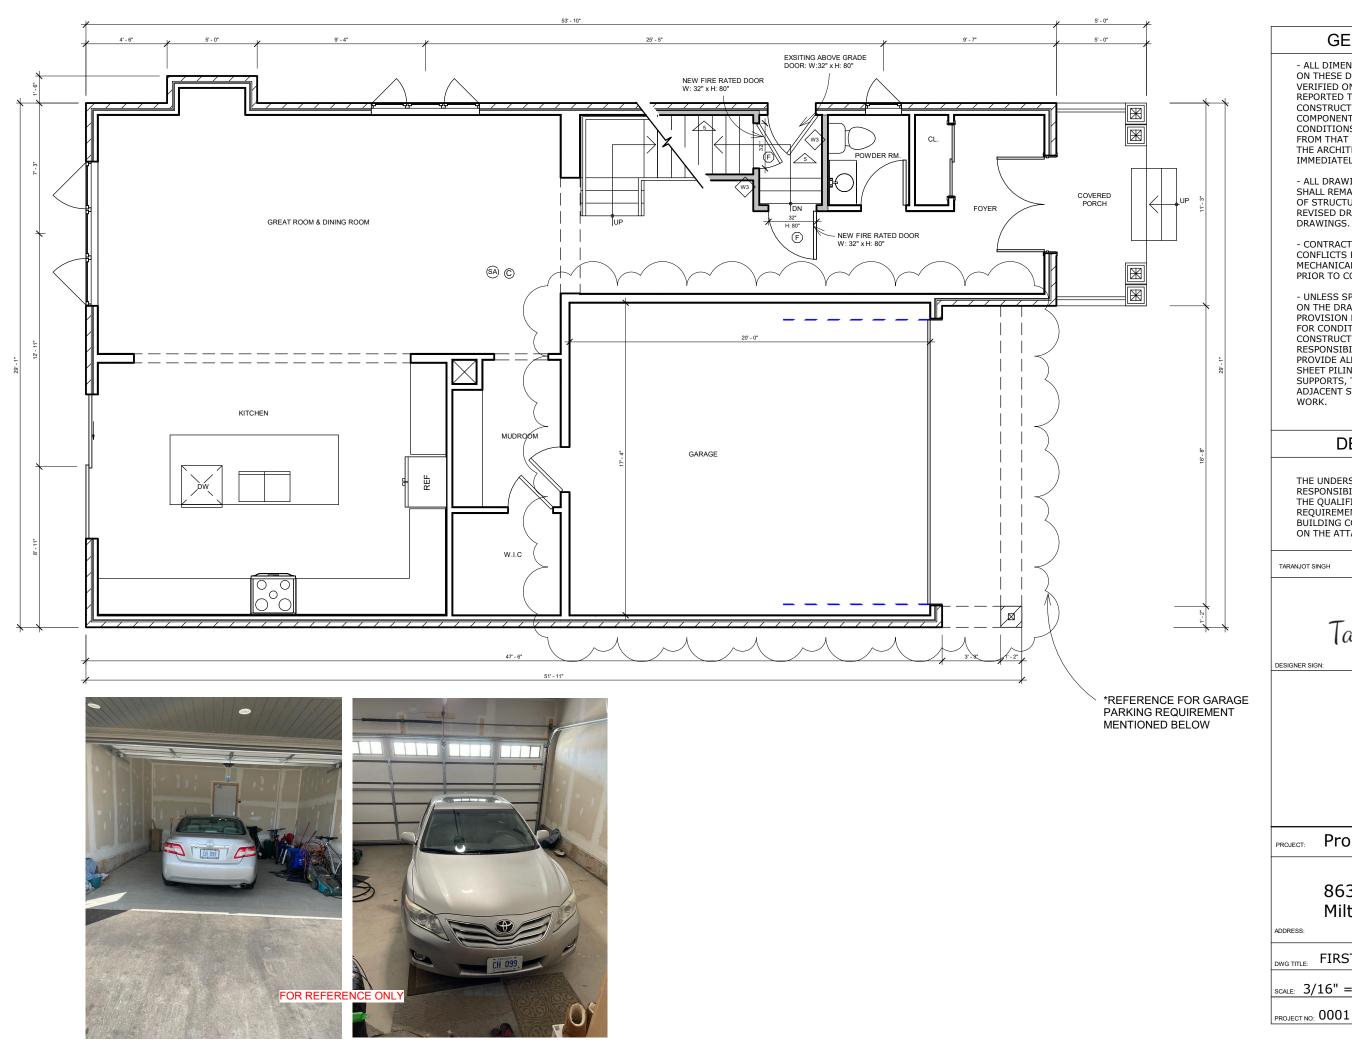
ADDRESS:

DWG TITLE: PROPOSED BASEMENT PLAN

SCALE: 3/16" = 1'-0'

PROJECT NO: 0001

A102



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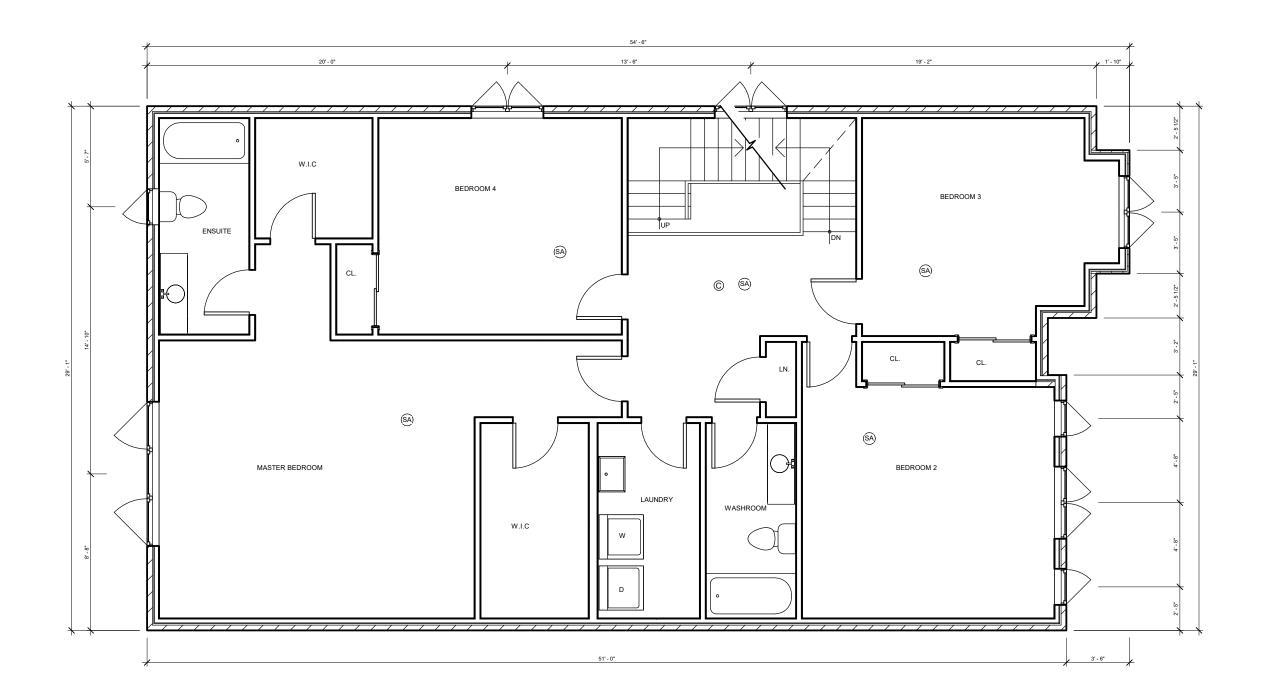
DESIGNER SIGN:

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863 Whitlock Ave Milton, ON L9E 1R8

DWG TITLE: FIRST FLOOR PLAN

 $_{\text{SCALE}:}$  3/16" = 1'-0"



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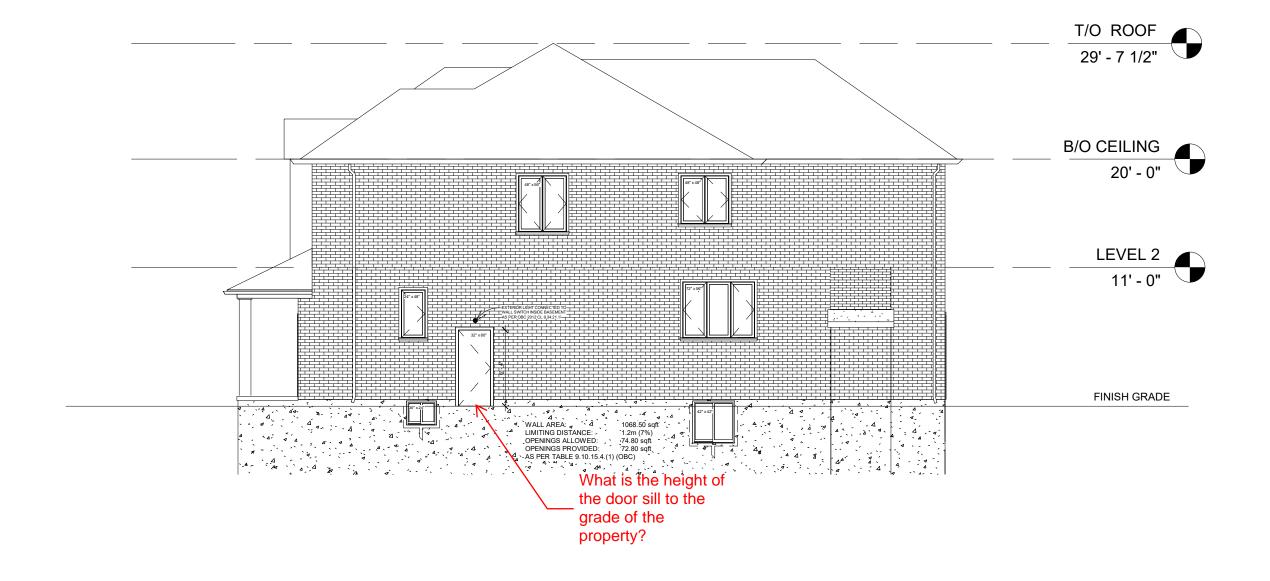
863 Whitlock Ave Milton, ON L9E 1R8

ADDRE

DWG TITLE: SECOND FLOOR PLAN

SCALE: 3/16" = 1'-0"

A104



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Proposed 2nd Dwelling

863 Whitlock Ave Milton, ON L9E 1R8

ADDRE

DWG TITLE: SIDE ELEVATION

SCALE: 1/8" = 1'-0"

A105



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ADDRE

DWG TITLE: SIDE ELEVATION

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A106